
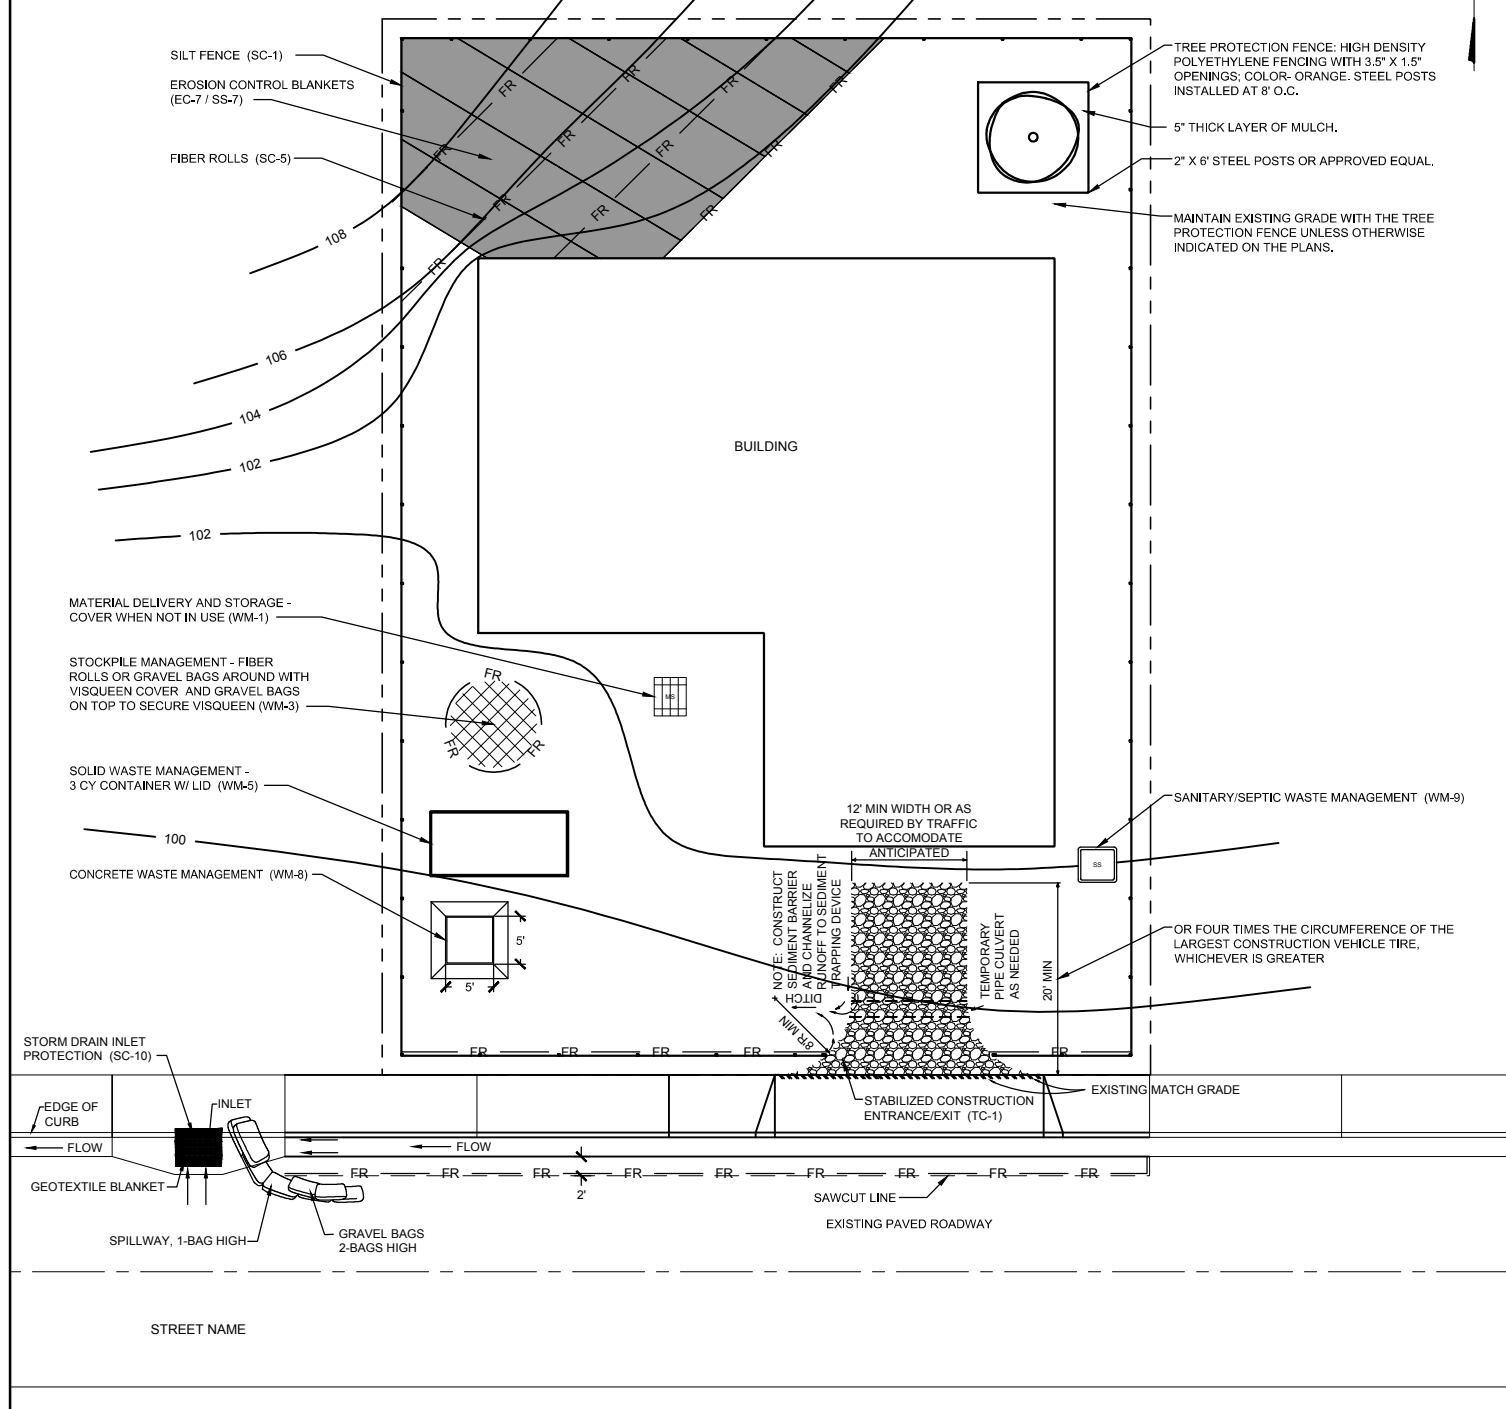


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- SITE PLAN CONTENT:**
- NORTH ARROW
  - SCALE
  - FRONTAGE AND SIDE STREETS
  - LOCATION OF IMPERVIOUS STRUCTURES AND IMPERVIOUS SURFACES
  - EXISTING VEGETATION
  - LAND SLOPE DIRECTION
  - NEARBY STORM DRAIN/INLETS
  - LOCATION OF NEARBY WATERWAYS OR BASINS
  - ALL BEST MANAGEMENT PRACTICES TO BE PLACED ON AND OFF-SITE

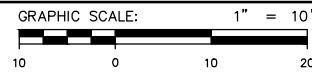

**LEGEND**

- 612 STREET ADDRESS NUMBER
- 001-184-014 ASSESSOR'S PARCEL NUMBER
- o (E) RIGHT OF WAY MONUMENT
- △ CONTROL POINT
- X 161.68 SPOT ELEVATION
- TREE
- MANHOLE
- o PP POWER POLE
- JP JOINT POLE W/STREET LIGHT
- FR FIBER ROLLS (SC-5)
- CS STOCKPILE MANAGEMENT (WM-3)
- CWM CONCRETE WASTE MANAGEMENT (WM-8)
- GB GRAVEL BAGS
- SILT FENCE
- E/C ELECTRIC LINE OR CABLE LINE
- G GAS LINE
- SS SANITARY SEWER LINE
- SD STORM DRAIN LINE
- W WATER LINE
- OHU OVERHEAD UTILITY LINE
- PROPERTY LINE
- FLOW LINE
- GRADE BREAK
- 100 CONTOURS
- FENCE, WOOD
- FENCE
- RETAINING WALL
- CRUSHED AGGREGATE
- AC CONFORM/TAPER GRIND
- NEW 2" AC/6" AB MIN. PVMT
- CONCRETE
- EROSION CONTROL BLANKETS (SS-7)
- VISQUEEN COVER

**KEY**

CASQA BMP FACT SHEET TITLE	FACT SHEET NO.
SILT FENCE	(CASQA / CALTRANS)
SILT FENCE	(XX-X / SC-1)

INDICATE SF OR CY OF SOIL DISTURBANCE

**SITE SPECIFIC NOTES OR MITIGATION MEASURES**

1. INSTALL VEGETATION FENCING UPSTREAM OF SENSITIVE WATER BODY

**REQUIRED REGULATORY PERMITS (LIST ALL THAT APPLY)**

1. COASTAL DEVELOPMENT PERMIT, CALIFORNIA COASTAL COMMISSION (CDP CCC)
2. CONSTRUCTION GENERAL PERMIT, STATE WATER RESOURCE CONTROL BOARD (CGP SWRCP)
3. CLEAN WATER ACT SECTION 10, US ARMY CORPS OF ENGINEERS (10 USACE)
4. CLEAN WATER ACT SECTION 404, US ARMY CORPS OF ENGINEERS (404 USACE)
5. CLEAN WATER ACT SECTION 401, REGIONAL WATER QUALITY CONTROL BOARD (401 RWQCB)
6. WASTE DISCHARGE REQUIREMENTS, REGIONAL WATER QUALITY CONTROL BOARD (WDR RWQCB)
7. CA FISH/WILDLIFE CODE SECTION 1600, LAKE/STREAMBED ALTERATION AGREEMENT (1600 CDFW)
8. OTHER (IDENTIFY) \_\_\_\_\_

**SITE PLAN**  
SCALE: 1" = 10'-0"



**CITY OF MONTEREY**  
**DEPARTMENT OF PLANS AND PUBLIC WORKS**  
580 PACIFIC STREET, MONTEREY, CA 93940  
TEL: 831.646.3921 WEBSITE: WWW.MONTEREY.ORG

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T KORMAN			
CAD DWG NAME:			
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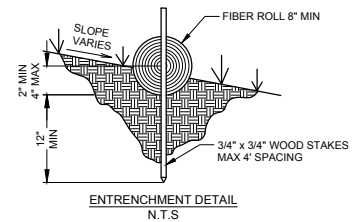
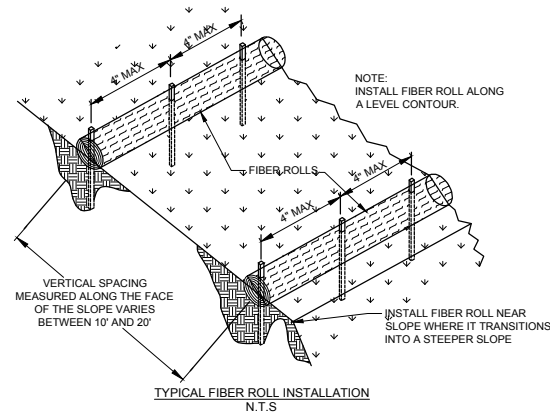
**PROJECT TITLE**  
**SAMPLE**  
**EROSION AND SEDIMENT CONTROL PLAN**

SCALE:	1" = 10'
DATE:	NOV 28, 2017
SHEET:	1
	SHEET 1 OF 2

REV: 09/01/2015 EROSION AND SEDIMENT CONTROL PLAN

# EROSION AND SEDIMENT CONTROL NOTES


1. **BEST MANAGEMENT PRACTICES (BMPs)** AT A MINIMUM, THE FOLLOWING BMPs ARE REQUIRED REGARDLESS OF WEATHER CONDITIONS, AND AS APPLICABLE TO THE CONSTRUCTION ACTIVITIES PLANNED. VERIFY ALL OF THE BELOW MEASURES ARE ADDRESSED ON THE ESCP SUBMITTAL, AS APPLICABLE.
- A. **WET WEATHER MEASURES** IF POSSIBLE, AVOID LAND-DISTURBING ACTIVITIES DURING THE WET WEATHER SEASON - OCTOBER 15 THROUGH APRIL 15. **OTHERWISE**, EXTRA BMP MATERIALS (FILTERS, FIBER ROLLS, GRAVEL BAGS, MULCH/STRAW, PLASTIC COVERS) SHALL BE KEPT ON-SITE FOR PRE-RAIN INSTALL.
- B. **EXISTING VEGETATION** PROTECT EXISTING VEGETATION; AVOID REMOVAL AS REQUIRED AND WHEREVER POSSIBLE; INSTALL APPROPRIATE/PROTECTIVE FENCING, PERIMETER CONTROLS PRIOR TO WORK.
- C. **EROSION AND SEDIMENT CONTROL** AS APPLICABLE, SLOPE AND SOIL STABILIZATION BMPs SHALL BE UTILIZED TO PREVENT SLOPE EROSION AND SOIL MOVEMENT ON-SITE AND OFF-SITE. NO SEDIMENT MAY LEAVE THE SITE, BE DEPOSITED OFF-SITE, OR POLLUTE STORM WATER RUNOFF FROM THE CONSTRUCTION SITE.
- D. **STOCKPILE MANAGEMENT** 1.) ALL STOCKPILES SHALL BE CONTAINED AND COVERED WHEN NOT ACTIVE, AND SECURED AT THE END OF EACH DAY. 2.) STOCKPILES SHALL BE SECURELY COVERED OVERNIGHT, AND PRIOR TO, DURING, AND AFTER RAIN EVENTS. 3.) NO MATERIAL SHALL LEAVE THE SITE OR MOVE INTO STREET.
- E. **WASTE MANAGEMENT** ALL CONSTRUCTION WASTE SHALL BE CONTAINED AND SECURELY COVERED ONSITE, INCLUDING TRASH, PAINT, GROUT, CONCRETE, ETC. ANY WASH OUT FACILITY SHALL BE CONTAINED, MAINTAINED AND ITS CONTENTS DISPOSED OF PROPERLY; NO MATERIAL SHALL BE WASHED INTO STREET.
- F. **VEHICLES AND EQUIPMENT** RESPONSIBLE PARTIES MUST ENSURE ALL VEHICLES AND EQUIPMENT ARE MAINTAINED IN GOOD WORKING ORDER, WILL NOT CAUSE DIRT, MUD, OIL, GREASE, OR FUEL TO BE DISCHARGED OR TRACKED OFF-SITE INTO THE STREET. INACTIVE VEHICLES/EQUIPMENT MUST USE COVER AND/OR DRIP PANS.
- G. **DRAIN/INLET PROTECTION & PERIMETER CONTROLS** DRAINS/INLETS THAT RECEIVE STORM WATER MUST BE COVERED OR OTHERWISE PROTECTED FROM RECEIVING SEDIMENT, MUD, DIRT, OR ANY DEBRIS, AND INCLUDE GUTTER CONTROLS AND FILTRATION WHERE APPLICABLE IN A MANNER NOT IMPEDING TRAFFIC OR SAFETY. PROPERLY INSTALLED SILT FENCING OR EQUIVALENT LINEAR CONTROL SHALL BE EVIDENT ALONG SITE PERIMETER TO PREVENT MOVEMENT OF SEDIMENT AND DEBRIS OFF-SITE. ALSO, CHANGING CONSTRUCTION CONDITIONS NECESSITATE THAT THE TYPE OF INLET AND DRAIN PROTECTION IMPLEMENTED BE CHANGED AND/OR ADJUSTED BY THE CONTRACTOR TO ADEQUATELY PROTECT THE STORM DRAIN SYSTEM DURING THE VARIOUS CONSTRUCTION PHASES.
- H. **SWEEPING** ALL IMPERVIOUS SURFACES (DRIVEWAYS, STREETS) SHALL BE PHYSICALLY SWEEPED (NOT WASHED OR HOSED DOWN), AND MAINTAINED FREE OF DEBRIS AND ACCUMULATIONS OF DIRT. NO TRACKING OFF-SITE.
- I. **DEWATERING** NO DEWATERING IS ALLOWED FROM CONSTRUCTION SITES UNLESS DISCHARGE IS AN EXCEPTION TO THE DISCHARGE PROHIBITION PER CITY CODE CH. 31.5-12(C). ASBS DRAINAGES HAVE GREATER RESTRICTIONS. ANY PROPOSED DEWATERING MUST BE REVIEWED/CLEARED BY CITY AND APPLICABLE REGULATORY AGENCIES.
- J. STORMWATER MIXED WITH NON-STORMWATER SHALL BE MANAGED AS NON-STORM WATER.



## FIBER ROLLS

NTS

1  
C-1

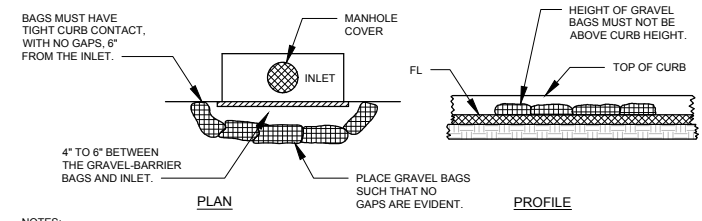


NOTES:  
1. GRAVEL BAGS SHALL CONTAIN 1\"/>

## DRAIN INLET BARRIER

NTS

2  
C-1

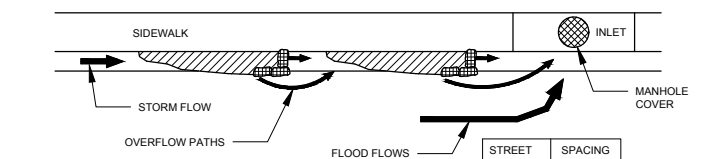


NOTES:  
1. FILL GRAVEL BAGS ABOUT 2/3 FULL BEFORE PLACING IN THE GUTTER.  
2. PLACE TWO OR MORE SETS OF GRAVEL BAGS IN A MANNER THAT RESULTS IN MAXIMUM SUPPORT. THE FLOW LINE BAG MUST BE LOWER THAN THE TOP OF THE CURB.

## CURB AND GUTTER CONTAINMENT

NTS

3  
C-1

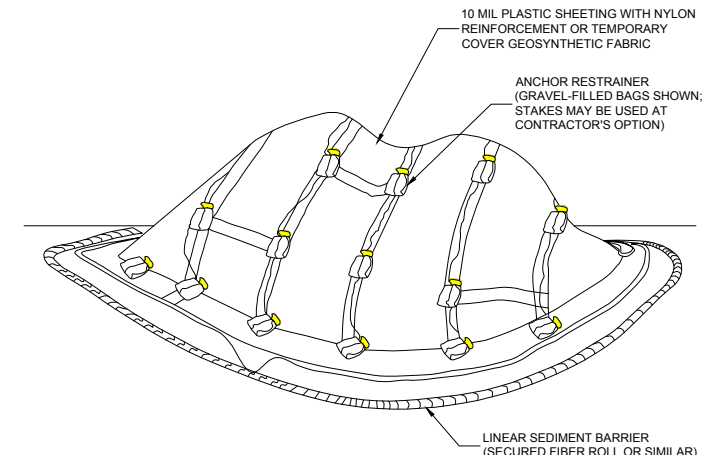


NOTES:  
1. ALL STOCKPILES SHALL BE CONTAINED AND COVERED WHEN NOT ACTIVE, AND SECURED AT THE END OF EACH DAY.  
2. STOCKPILES SHALL BE SECURELY COVERED OVERNIGHT, AND PRIOR TO, DURING, AND AFTER RAIN EVENTS.  
3. NO MATERIAL SHALL LEAVE THE SITE OR MOVE INTO STREET.  
4. PLASTIC SHEETING HAS LIMITATIONS DUE TO SUNLIGHT BREAKDOWN, HARD TO MANAGE IN WINDY CONDITIONS, AND CAN INCREASE RUNOFF ISSUE FOR PERIMETER CONTROLS. INSPECT FREQUENTLY OR USE GEOSYNTHETIC FABRIC AS APPLICABLE.  
5. DO NOT LOCATE WITHIN 50 FEET OF A STORM DRAIN.

## TEMPORARY COVER ON STOCKPILE

NTS

5  
C-1

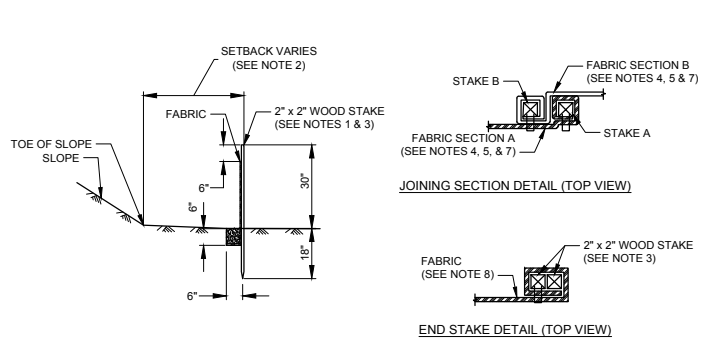


NOTES:  
1. STAKE DIMENSIONS ARE NOMINAL.  
2. DIMENSIONS MAY VARY TO FIT FIELD CONDITIONS.  
3. STAKES SHALL BE SPACED AT 8'-0\"/>

## SILT FENCE

NTS

4  
C-1

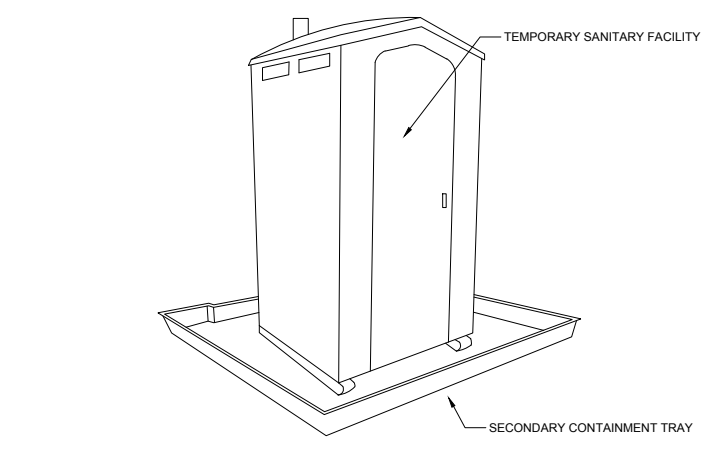

**STORAGE AND DISPOSAL PROCEDURES**  
1. TEMPORARY SANITARY FACILITIES SHOULD BE LOCATED AWAY FROM DRAINAGE FACILITIES, WATERCOURSES, AND FROM TRAFFIC CIRCULATION. IF SITE CONDITIONS ALLOW, PLACE PORTABLE FACILITIES A MINIMUM OF 50 FEET FROM DRAINAGE CONVEYANCES AND TRAFFIC AREAS.  
2. WHEN SUBJECTED TO HIGH WINDS OR RISK OF HIGH WINDS, TEMPORARY SANITARY FACILITIES SHOULD BE SECURED TO PREVENT OVERTURNING.  
3. TEMPORARY SANITARY FACILITIES MUST BE EQUIPPED WITH SECONDARY CONTAINMENT TRAYS TO PREVENT DISCHARGE OF POLLUTANTS TO THE STORMWATER DRAINAGE SYSTEM OF THE RECEIVING WATER.  
4. ARRANGE FOR REGULAR WASTE COLLECTION. DO NOT ALLOW SANITARY FACILITY TO BECOME OVERFULL.

## SANITARY WASTE MANAGEMENT

NTS

6  
C-1



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580 PACIFIC STREET, MONTEREY, CA 93940  
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**PROJECT TITLE**  
**SAMPLE**  
**EROSION AND SEDIMENT CONTROL PLAN NOTES AND DETAILS**

SCALE:  
AS SHOWN  
DATE:  
NOV 28, 2017  
SHEET:  
2  
SHEET 2 OF 2